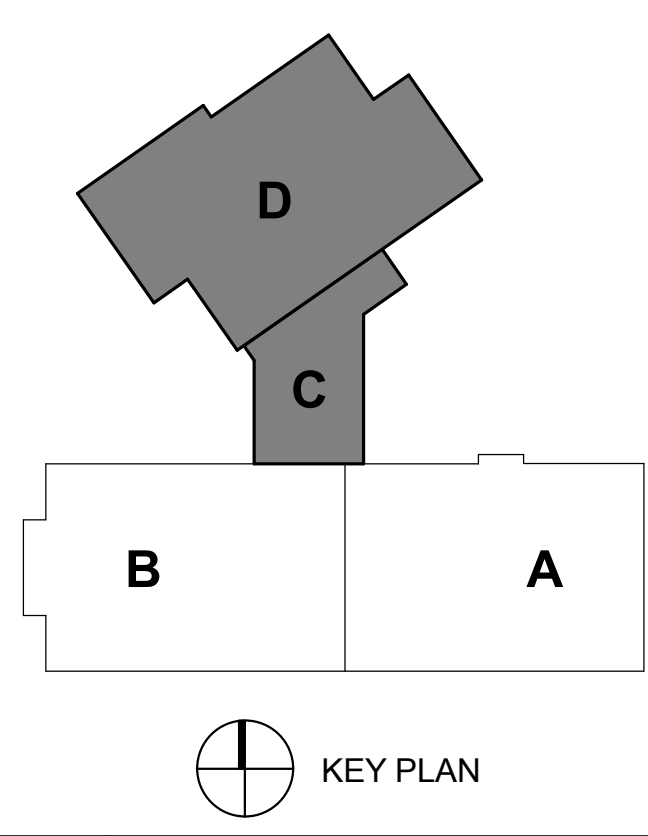
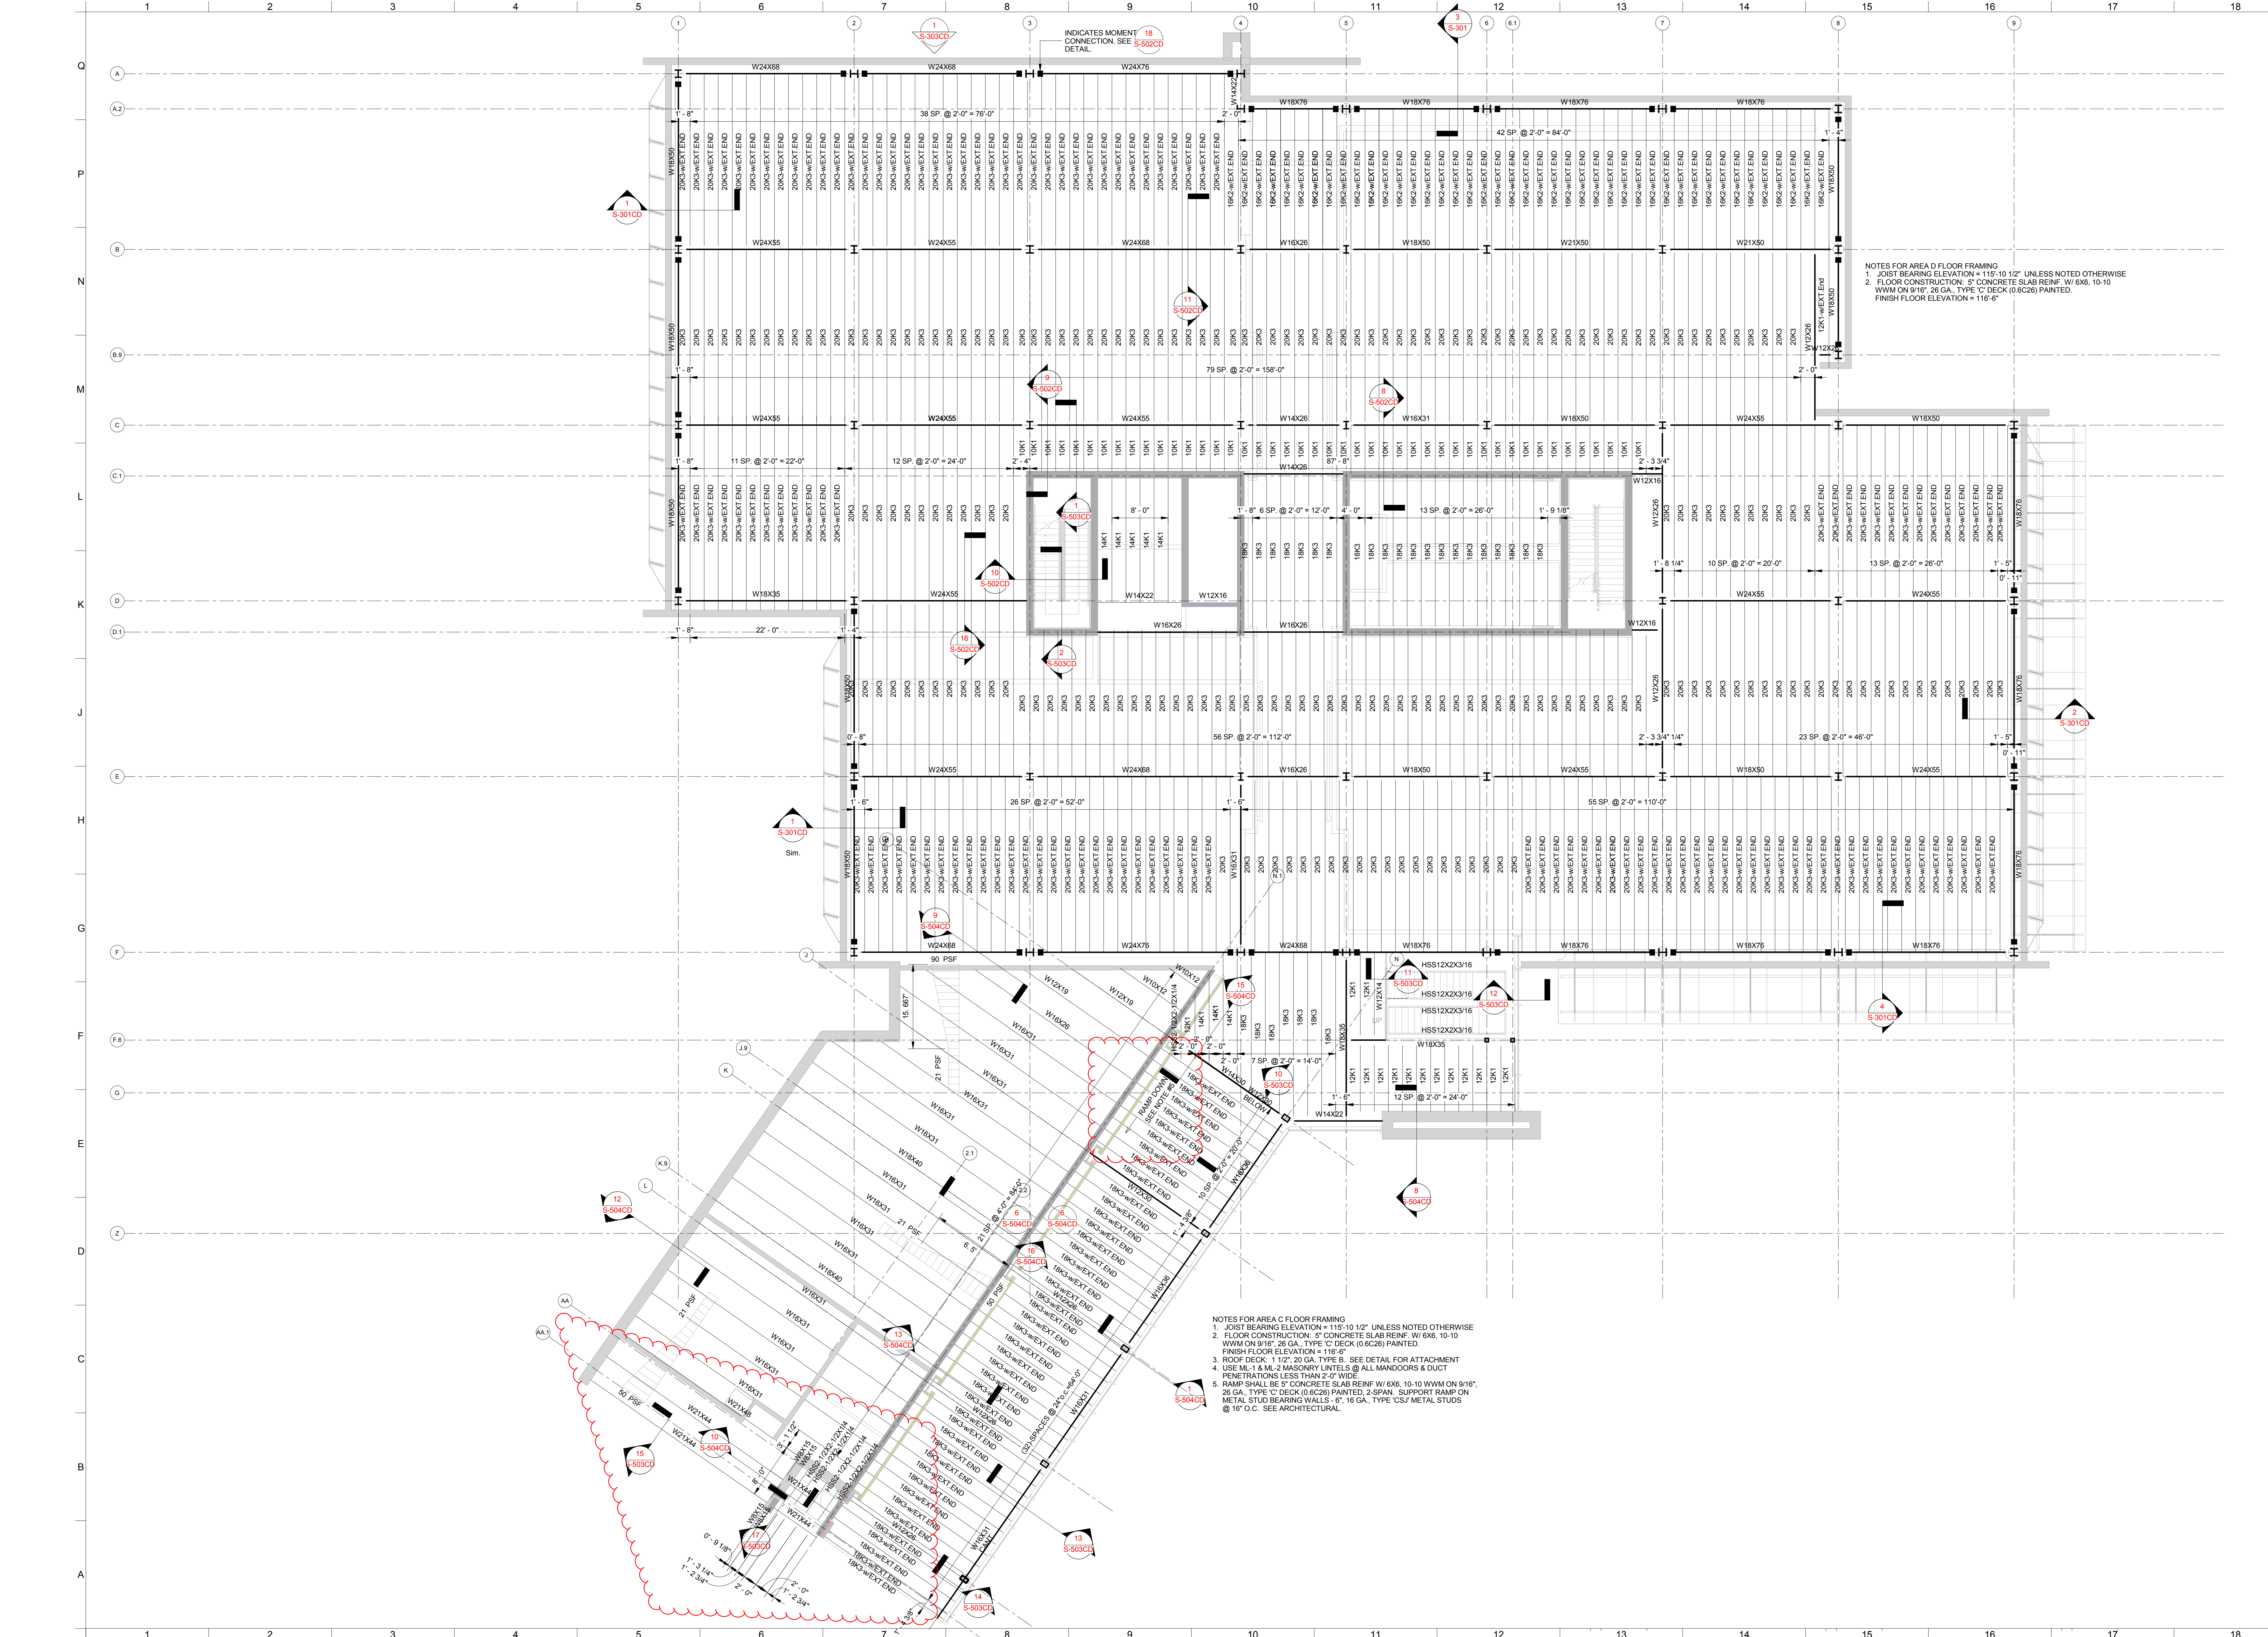


- NOTES:
1. CONTINUOUS FOOTINGS, GRADE BEAMS, PAD FOOTINGS, & ELEVATOR PAD SHALL BE SUPPORTED ON GEOPIER ELEMENTS.
 2. GEOPIER ELEMENT DESIGN INCLUDING SIZE & SPACING BY THE GEOPIER SUPPLIER. SEE THE PLAN FOR WALL LOADS. MAXIMUM GEOPIER ELEMENT SPACING = 10'-0". PROVIDE (6) MINIMUM GEOPIER ELEMENTS AT ELEVATOR PAD.
 3. SEE THE DETAILS FOR GEOPIER ORIENTATION UNDER THE PAD FOOTINGS.
 4. SEE THE DETAILS FOR PAD FOOTING REINFORCING.
 5. SEE THE SCHEDULE FOR CONTINUOUS FOOTING & GRADE BEAM REINFORCING.
 6. FLOOR CONSTRUCTION: 4" CONCRETE SLAB ON GRADE REINF. W/ 6#8; 10-12 W/M OVER 10# W/M VAPOR BARRIER & 4" COMPACTED SAND & GRAVEL LAYER.
 7. FINISH FLOOR ELEVATION = 100'-0".
 8. TOP OF GRADE BEAM ELEVATION = 99'-4" UNO
 9. TOP OF ELEVATOR PAD = 99'-0".
 10. COAT THE LOWER 2'-0" OF THE EXTERIOR STEEL COLUMNS TO PROTECT FROM CORROSION. SEE ARCHITECTURAL FOR CONCRETE BASE DETAIL & LOCATIONS.

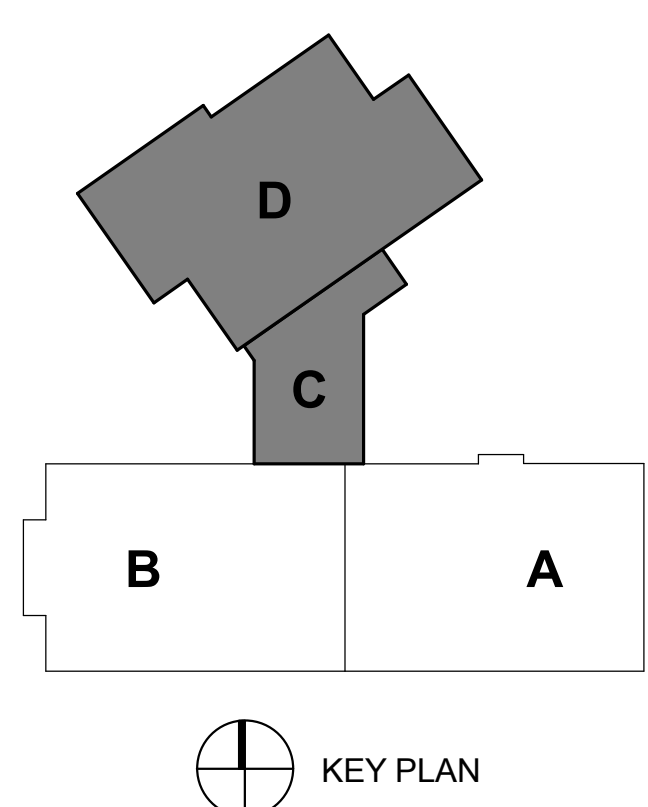


<p>PROJECT CONSULTANTS</p> <p>MECH/ELEC ENGINEER Davis Design Group 1220 Main Street Lincoln, NE 68502 (402) 476-9700</p> <p>STRUCTURAL ENGINEER Davis Design Group 1220 Main Street Lincoln, NE 68502 (402) 476-9700</p> <p>CIVIL ENGINEER Dillon Associates 11111 S. 111th Street Lincoln, NE 68504 (402) 474-5311</p>		<p>DESIGN ENGINEER</p> <p>PROJECT ENGINEER</p> <p>DATE: 10/23/2012</p>
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<p>KITCHEN CONSULTANT</p> <p>Foodlines 209 West Street Lincoln, NE 68501 (402) 475-1787</p>		<p>PROJECT NO. 11-0214</p>
<p>SINCLAIR hills architec</p> <p>700 G St Lincoln, NE 68508 T: 402.476.7331 F: 402.478.8341</p>		<p>Foundation Plan</p>
<p>DAVIS DESIGN PROJECT NO.</p>		<p>11-0214</p>
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NOTES FOR AREA D FLOOR FRAMING
 1. JOIST BEARING ELEVATION = 115'-10 1/2" UNLESS NOTED OTHERWISE
 2. FLOOR CONSTRUCTION: 5" CONCRETE SLAB REINF. W/ #6, 10-10 W/M ON 9"18", 28 GA. TYPE 'C' DECK (0.6C28) PAINTED. FINISH FLOOR ELEVATION = 116'-6"

NOTES FOR AREA C FLOOR FRAMING
 1. JOIST BEARING ELEVATION = 115'-10 1/2" UNLESS NOTED OTHERWISE
 2. FLOOR CONSTRUCTION: 5" CONCRETE SLAB REINF. W/ #6, 10-10 W/M ON 9"18", 28 GA. TYPE 'C' DECK (0.6C28) PAINTED. FINISH FLOOR ELEVATION = 116'-6"
 3. ROOF DECK: 1 1/2" 20 GA. TYPE B. SEE DETAIL FOR ATTACHMENT PENETRATIONS LESS THAN 2'-0" WIDE
 4. USE #1 & #2 MASONRY UNITS @ ALL MANDOOKS & DUCT
 5. RAMP SHALL BE 5" CONCRETE SLAB REINF W/ #6, 10-10 W/M ON 9"18", 28 GA. TYPE 'C' DECK (0.6C28) PAINTED. 2-SPAN. SUPPORT RAMP ON METAL STUD BEARING WALLS - 8" 16 GA. TYPE 'CSJ' METAL STUDS @ 16" O.C. SEE ARCHITECTURAL.



KEY PLAN

0111-2014-New Bldg_STRUCT_Covering_Architect

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 MR
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 On **October 29, 2012**

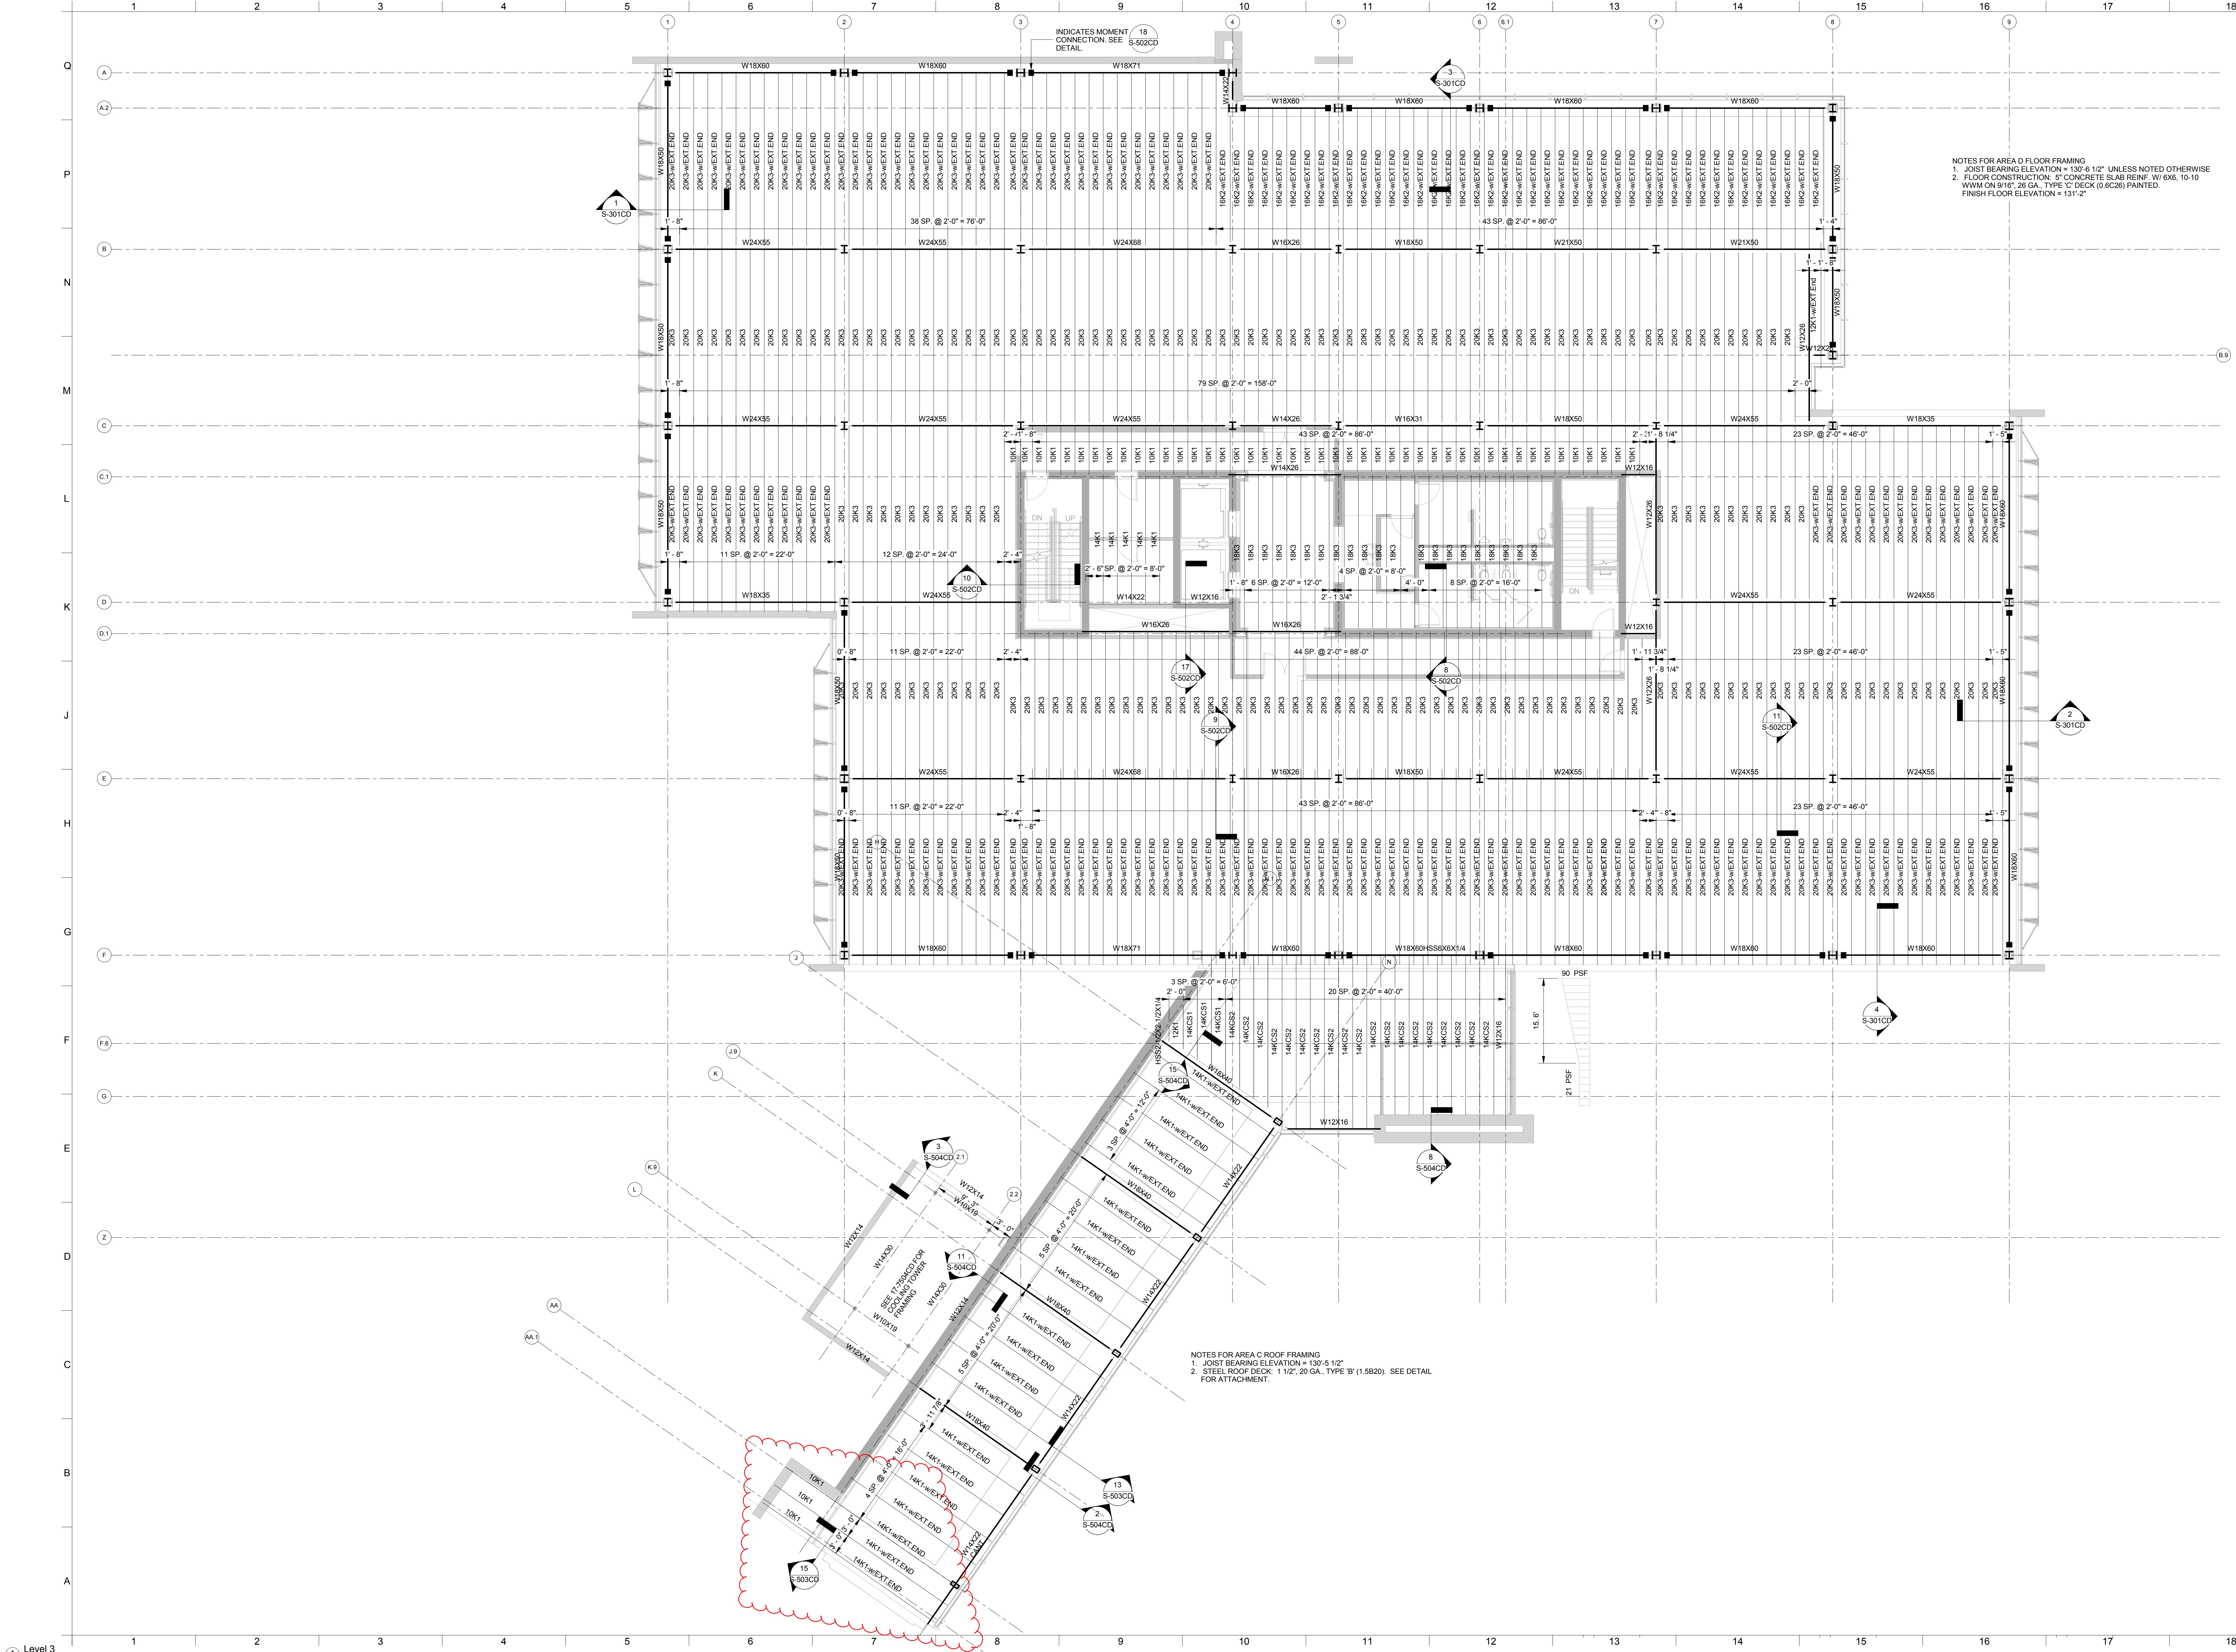
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4H Renovation & NIC Building

First Floor Framing Plan

DAVIS DESIGN PROJECT NO. 11-0214
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NOTES FOR AREA D FLOOR FRAMING
 1. JOIST BEARING ELEVATION = 130'-6 1/2" UNLESS NOTED OTHERWISE
 2. FLOOR CONSTRUCTION: 5" CONCRETE SLAB REIN. W/ #6X8, 10-10 W/M ON 18" @ 20 GA., TYPE 'C' DECK (0.625) PAINTED.
 FINISH FLOOR ELEVATION = 131'-2"

NOTES FOR AREA C ROOF FRAMING
 1. JOIST BEARING ELEVATION = 130'-5 1/2"
 2. STEEL ROOF DECK 1 1/2", 20 GA., TYPE 'B' (1.5820). SEE DETAIL FOR ATTACHMENT.

Level 3
 1/8" = 1'-0"

1111 2014 New Bldg. STRUCTURE.dwg, 10/29/2012

DESIGN ENGINEER: [REDACTED]
 PROJECT ENGINEER: [REDACTED]
 DRAWN BY: [REDACTED]
 DATE: 10/29/2012

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On **October 29, 2012**
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4H Renovation & NIC Building

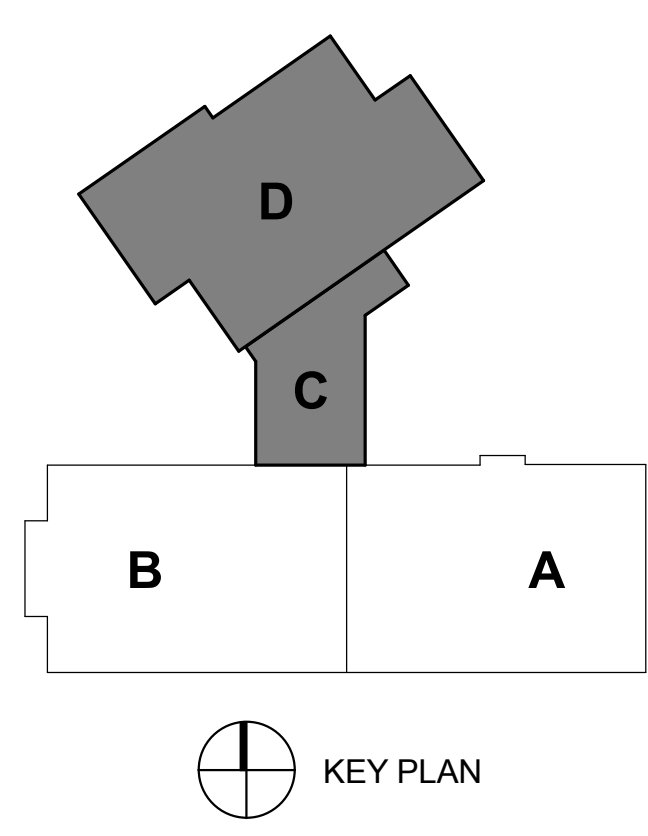
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Second floor Framing Plan

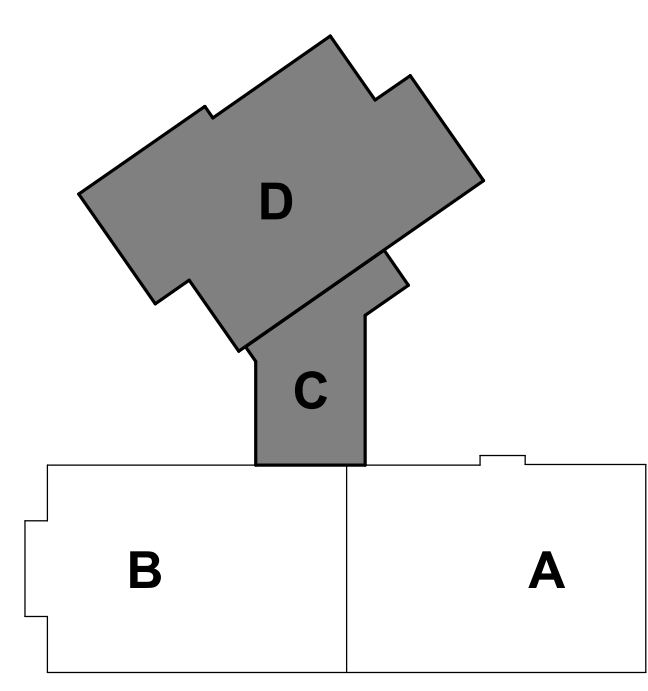
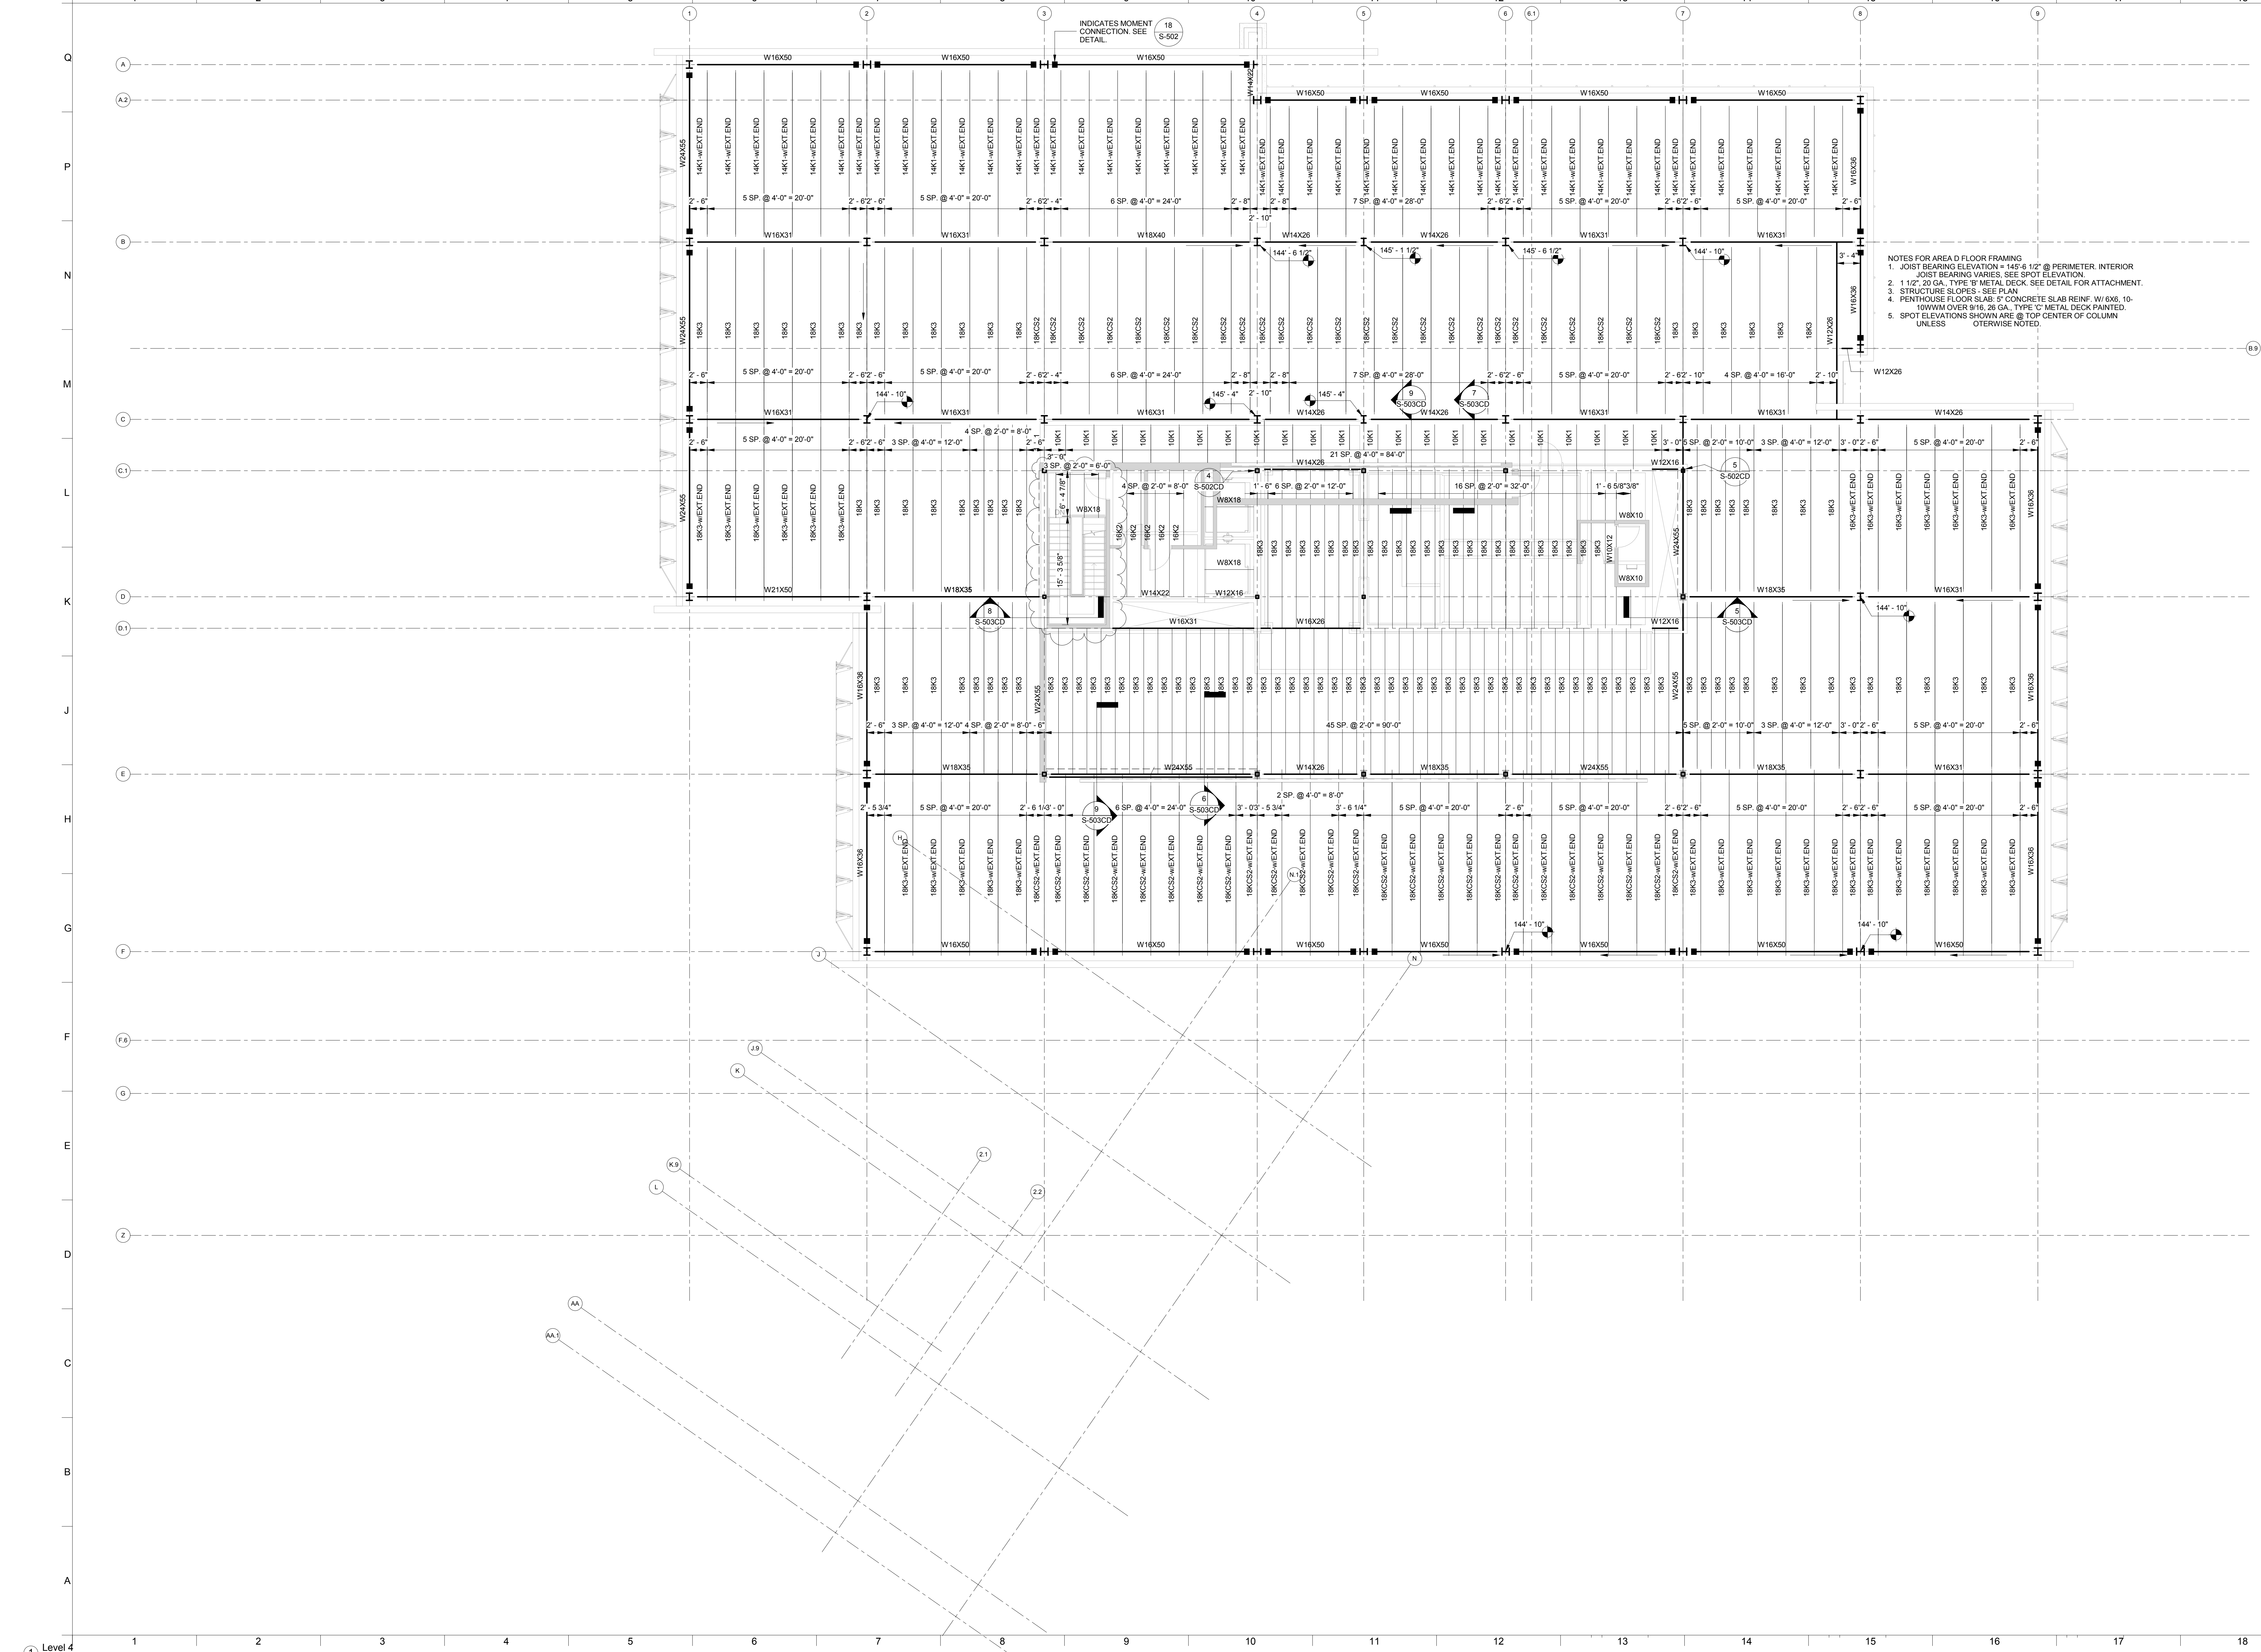
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KEY PLAN



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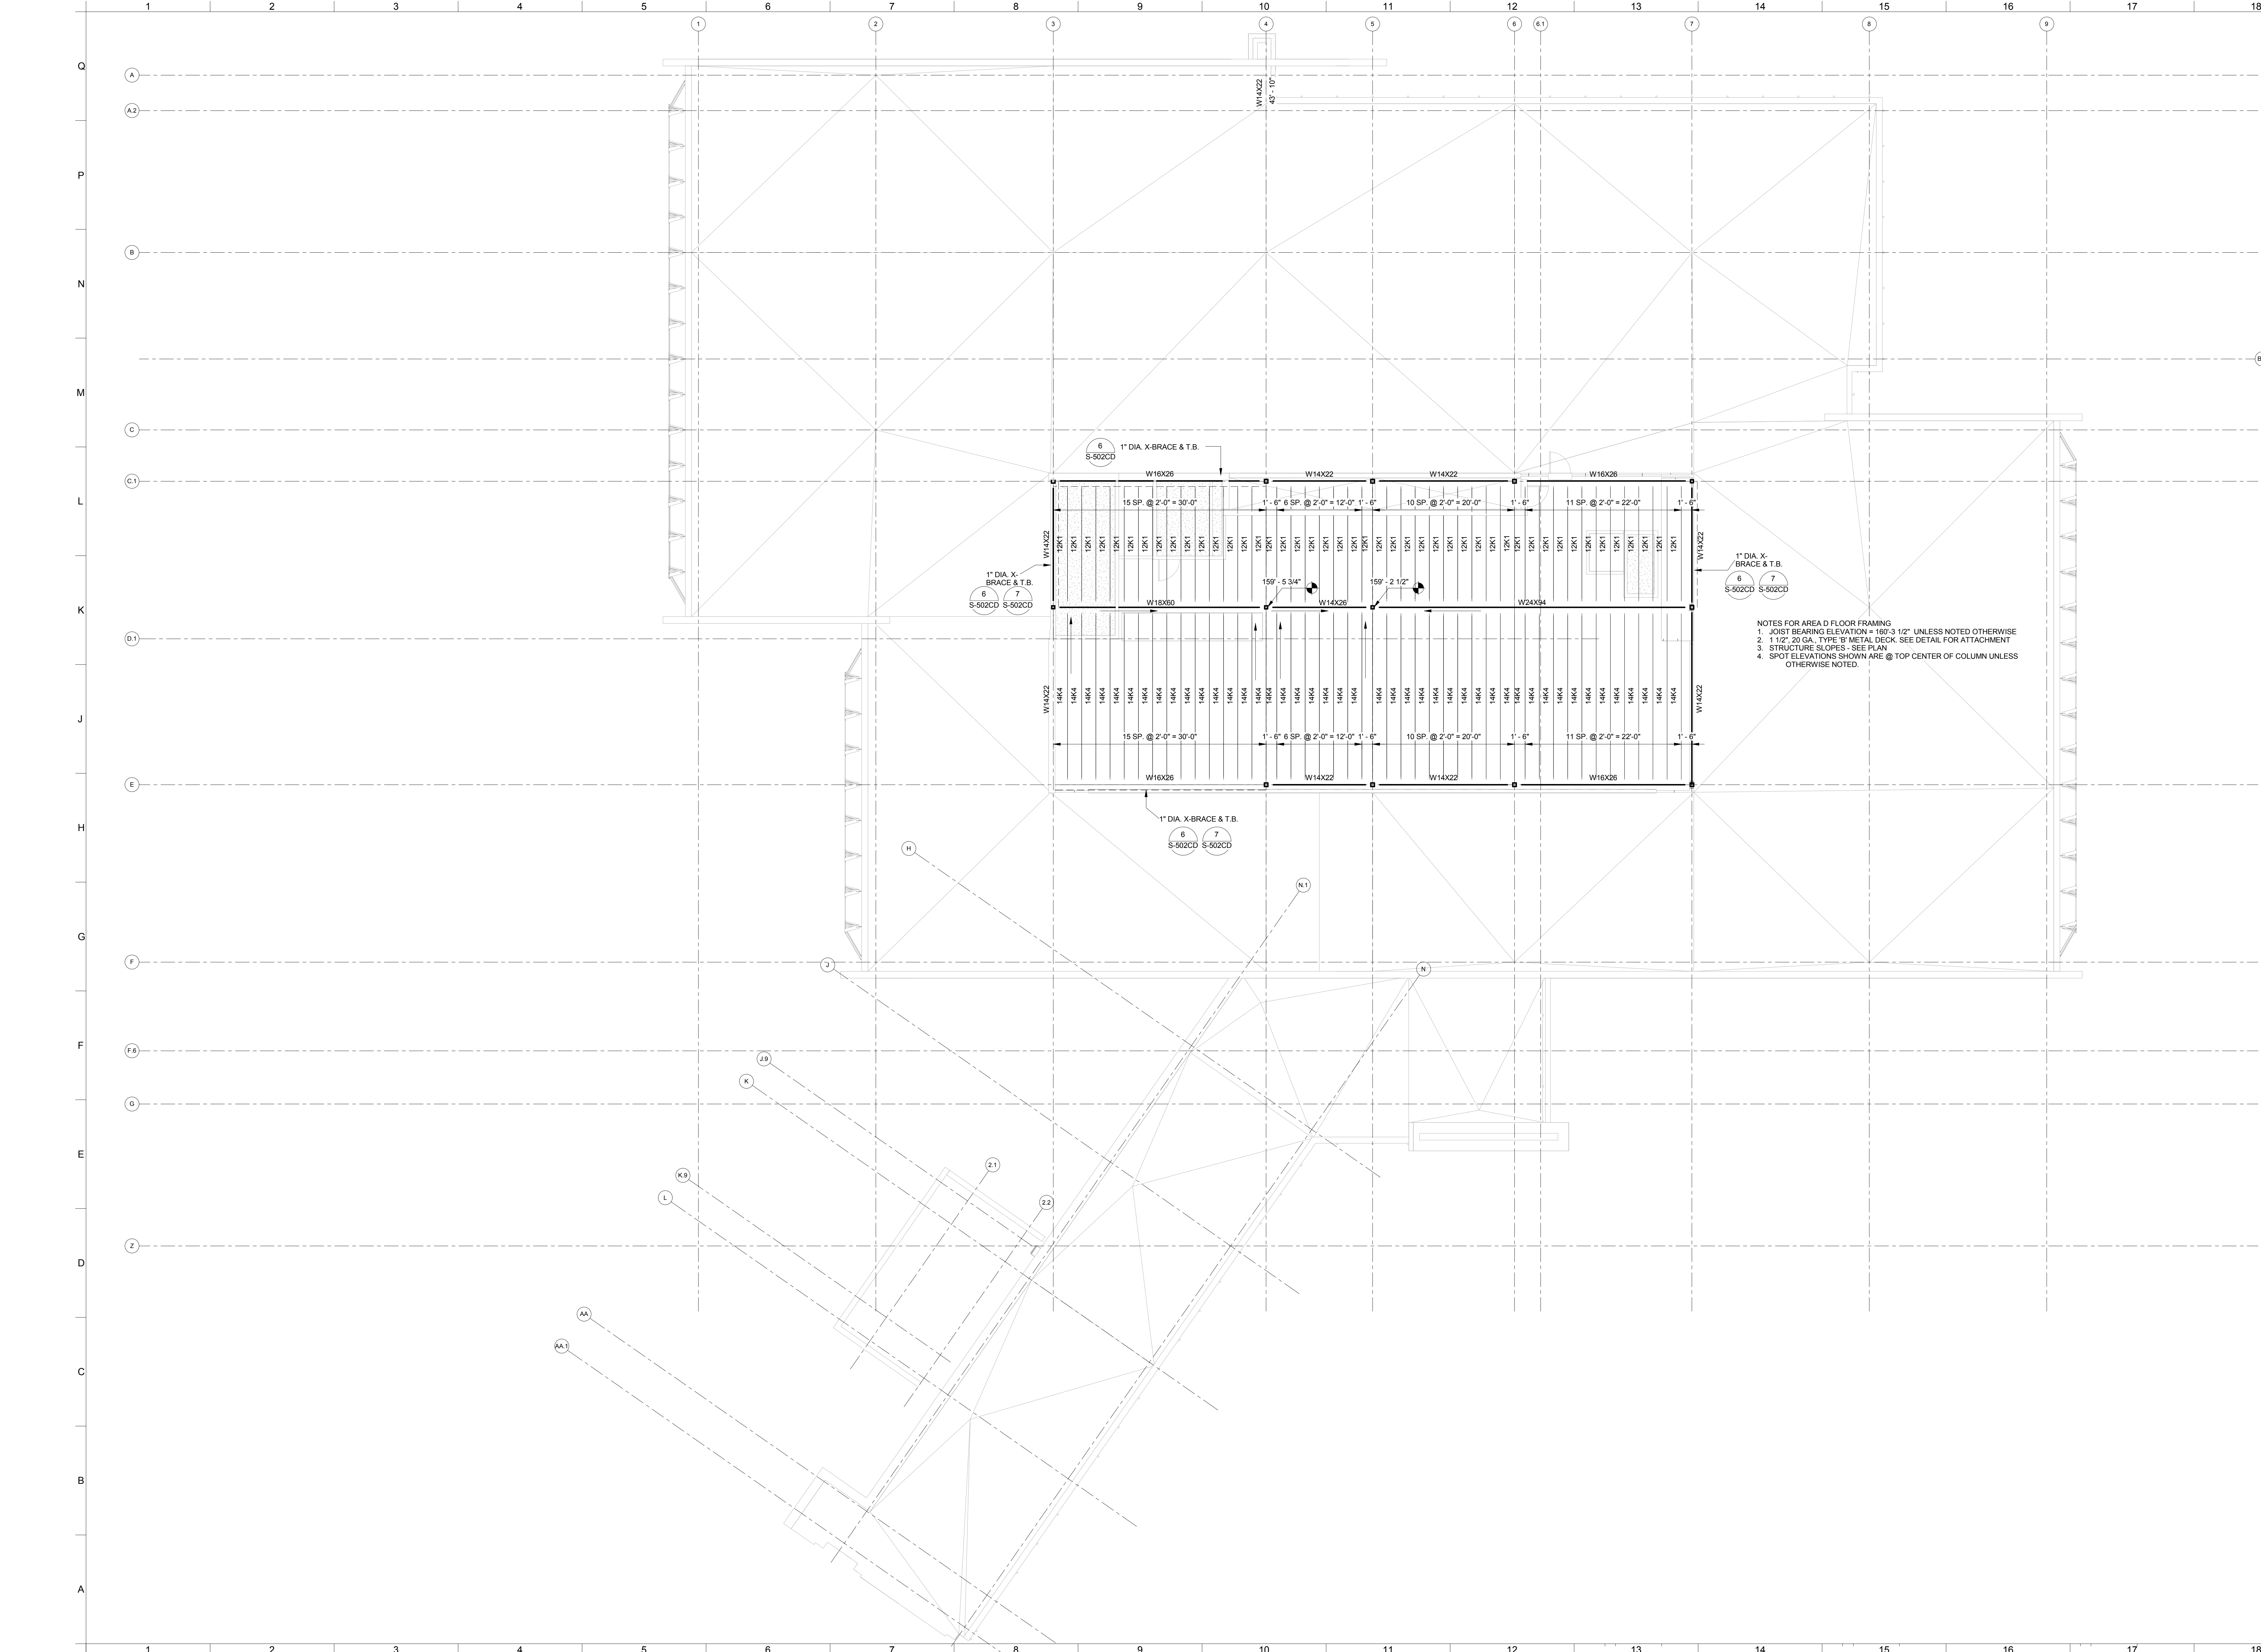
<p>PROJECT CONSULTANTS</p> <p>KITCHEN CONSULTANT Frostline 2000 West Lincoln, NE 68502 (402) 475-1787</p> <p>CIVIL ENGINEER Olson Associates 1111 Lincoln, NE 68502 (402) 474-6311</p>	<p>MECH/ELEC ENGINEER Davis Design 1221 Lincoln, NE 68502 (402) 476-9700</p> <p>STRUCTURAL ENGINEER Davis Design 1221 Lincoln, NE 68502 (402) 476-9700</p>	<p>DESIGN ENGINEER</p> <p>PROJECT ENGINEER</p> <p>Drawn by: MR 10/20/2012</p> <p>This document originally issued and sealed by: Darin D. Spiering Registered Professional Engineer E-6554</p> <p>On: October 29, 2012</p> <p>This media should not be considered a certified document and is to be used for bidding purposes only.</p>
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4H Renovation & NIC Building

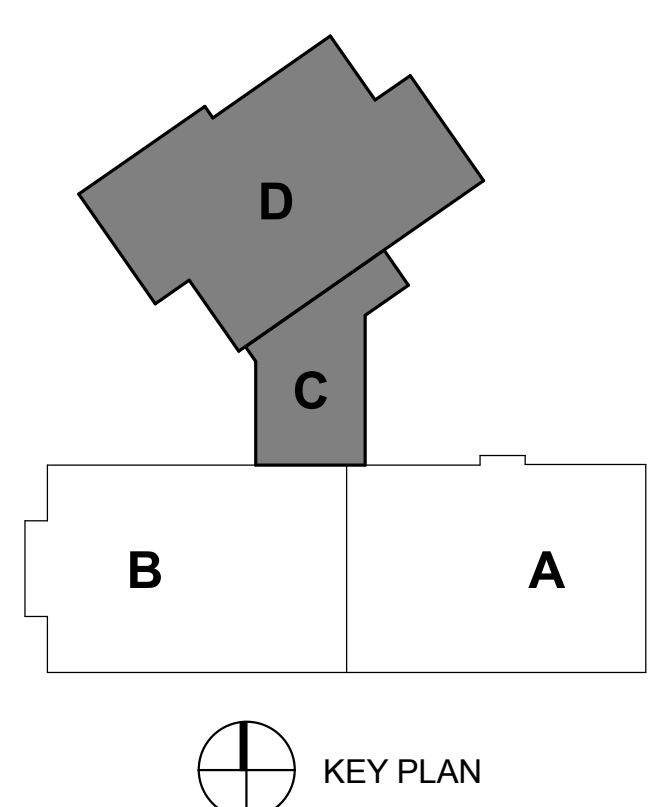
<p>SINCLAIR hills architects Lincoln, NE 68508 T: 402-476-7331 F: 402-476-8341</p>	<p>Roof Framing Plan</p>
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Level 5
1/8" = 1'-0"



KEY PLAN

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<p>SINCLAIR hills architects 700 O St Lincoln, NE 68508 T: 402-478-7331 F: 402-478-8341</p> <p>Penthouse Roof Framing Plan</p>	
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